




752.1-2

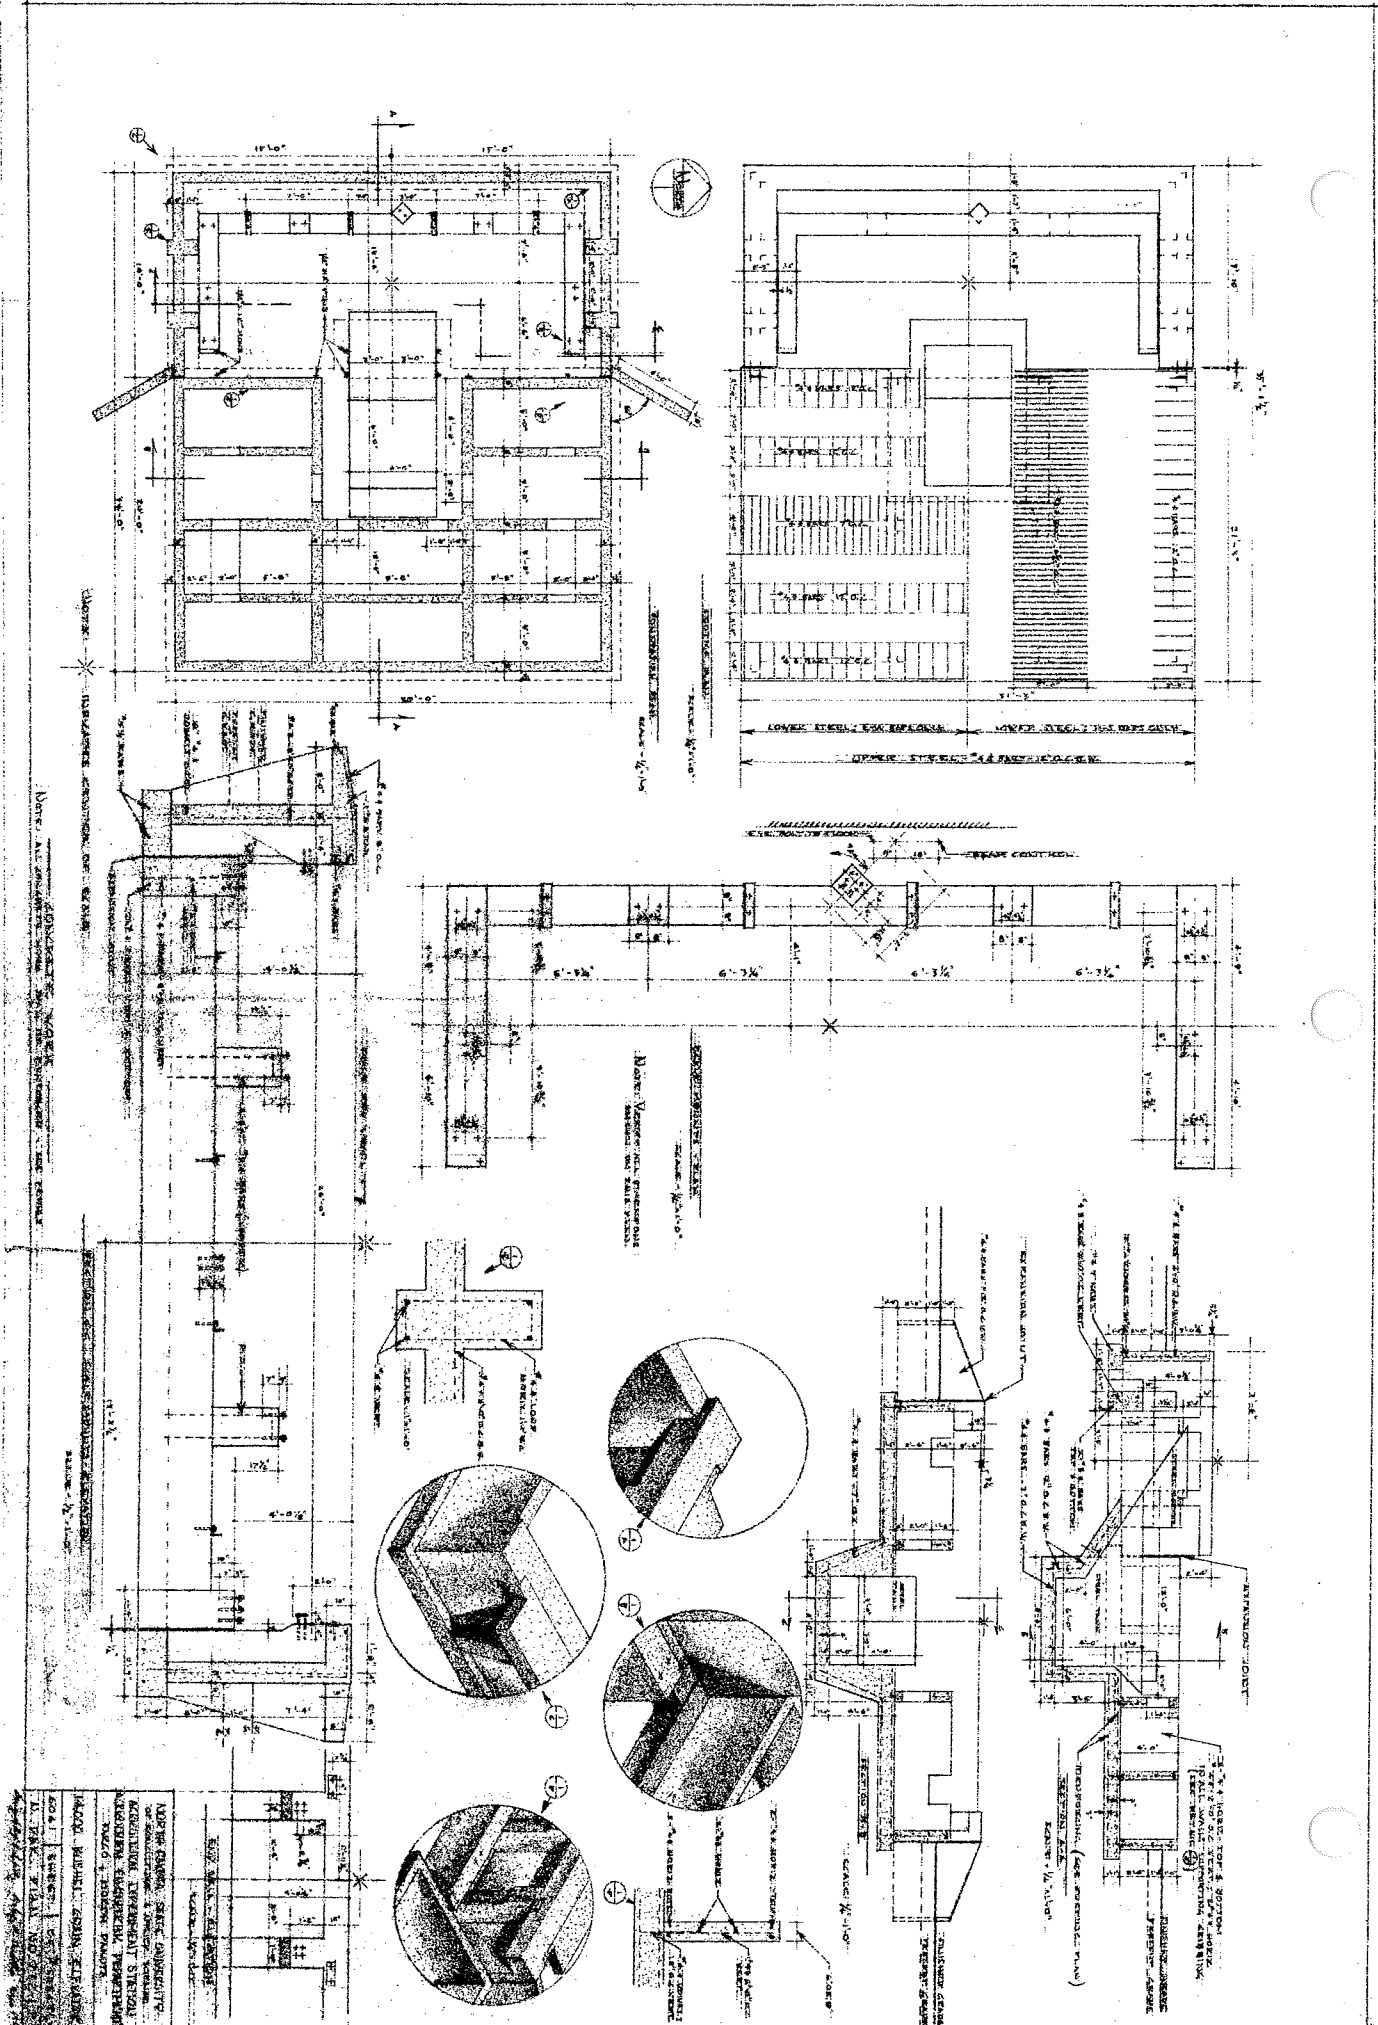


NO. 752.1-2	DATE	SCALE
1		
2		
3		
100		

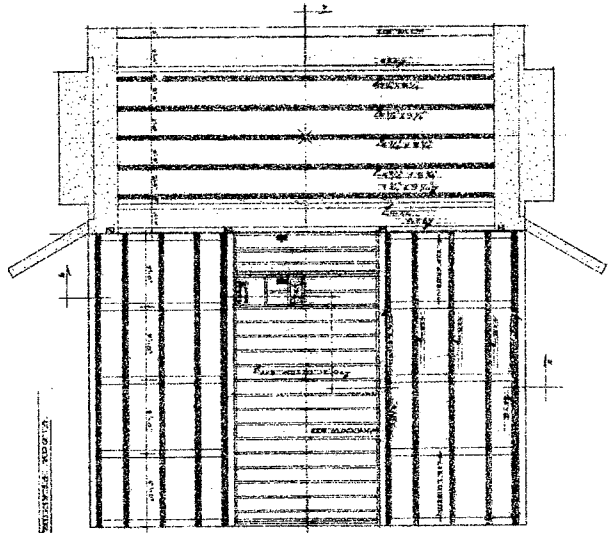

UPPER FLOOR PLAN SCALE 1/8" = 1'-0"

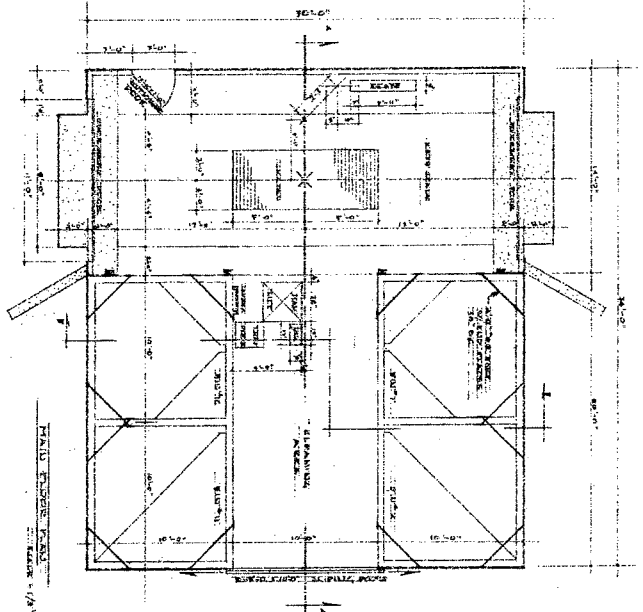


LOWER FLOOR PLAN SCALE 1/8" = 1'-0"



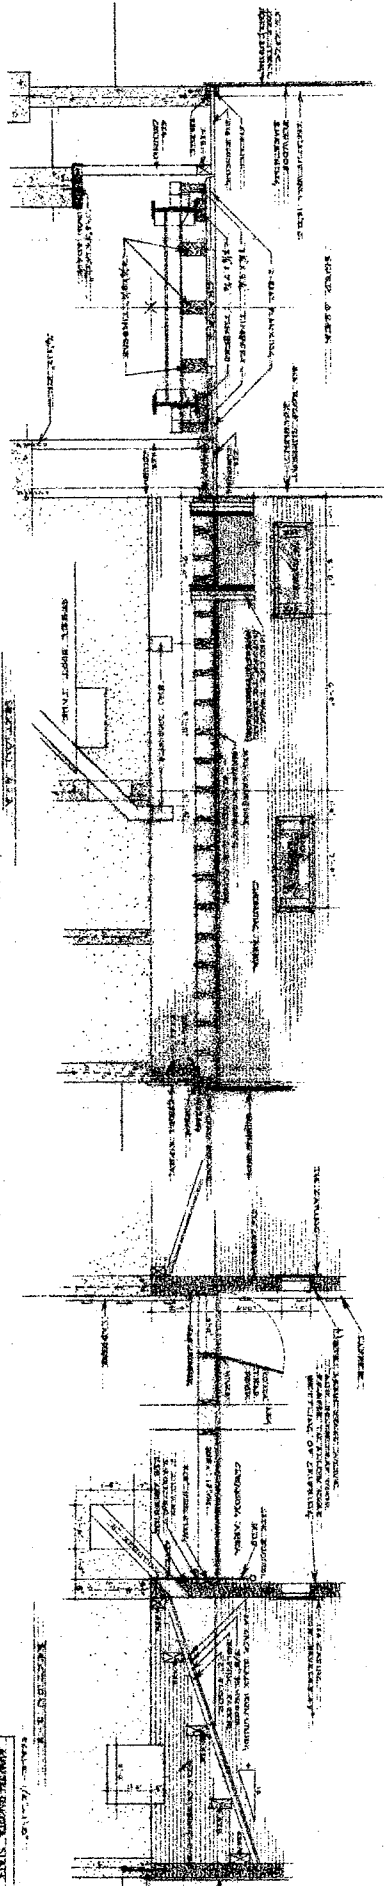


ELEVATION SCALE 1/8" = 1'-0"

ARCHITECTURE  
 1011 MARKET STREET  
 PHILADELPHIA, PENNSYLVANIA  
 19107



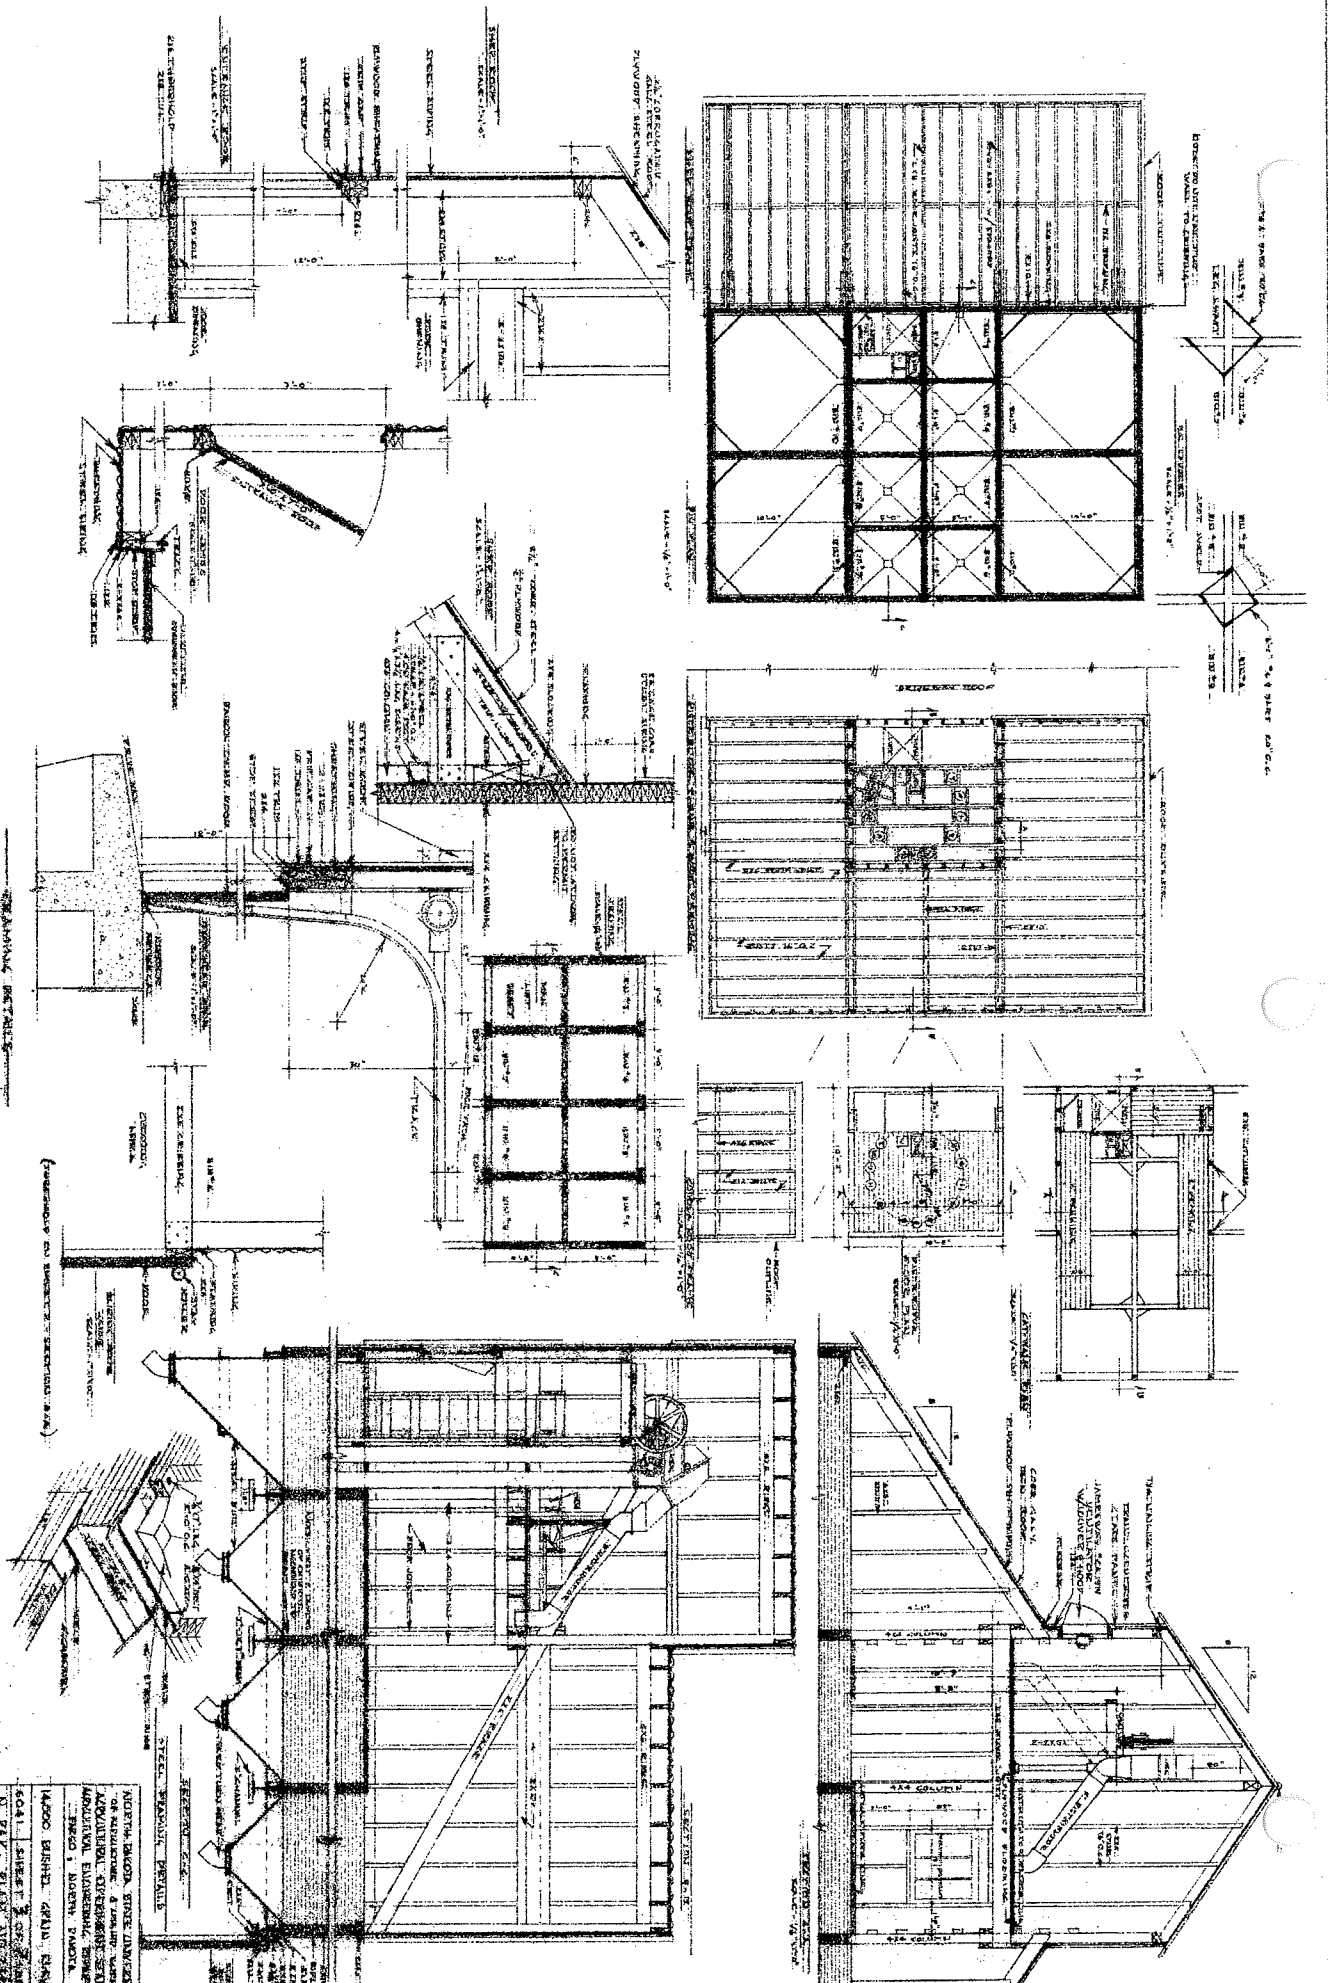


NORTH BACON STEEL UNWEARING  
 OF MATERIALS & JOINTS UNDER  
 ACCIDENTAL OVERLOADS. SEE  
 SPECIFICATIONS FOR DETAILS  
 BASED ON NORTH PACIFIC  
 14000 BISHOP, DETAIL, BISHOP  
 10411 SHEET 2 OF 7  
 N. PAC. STEEL CO.

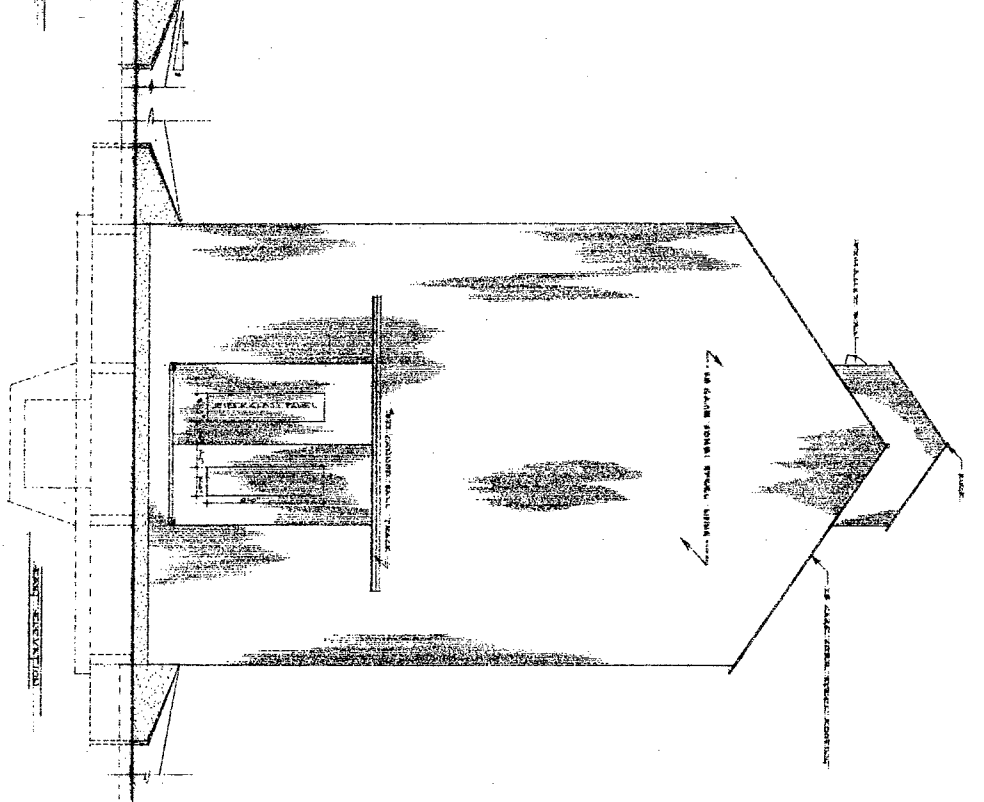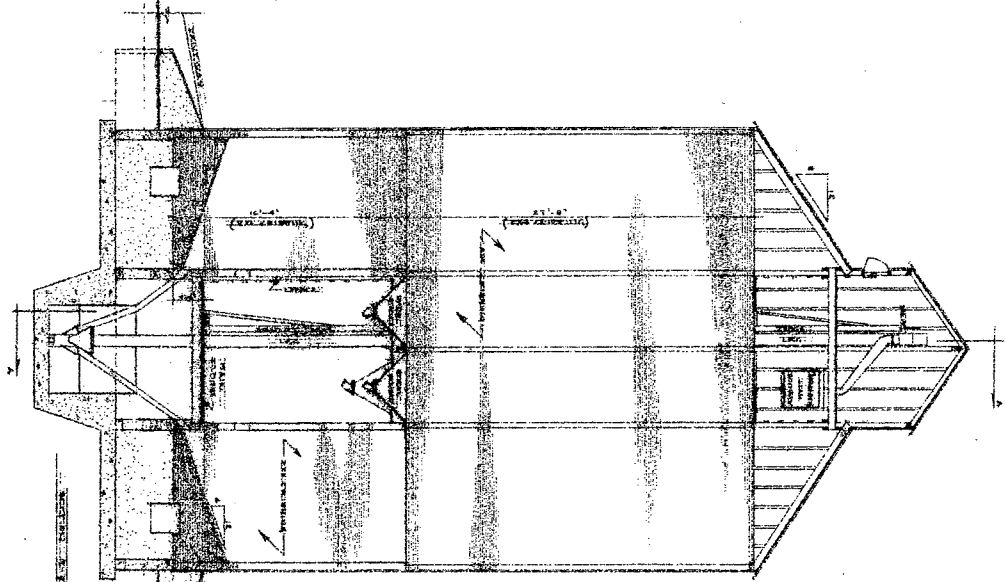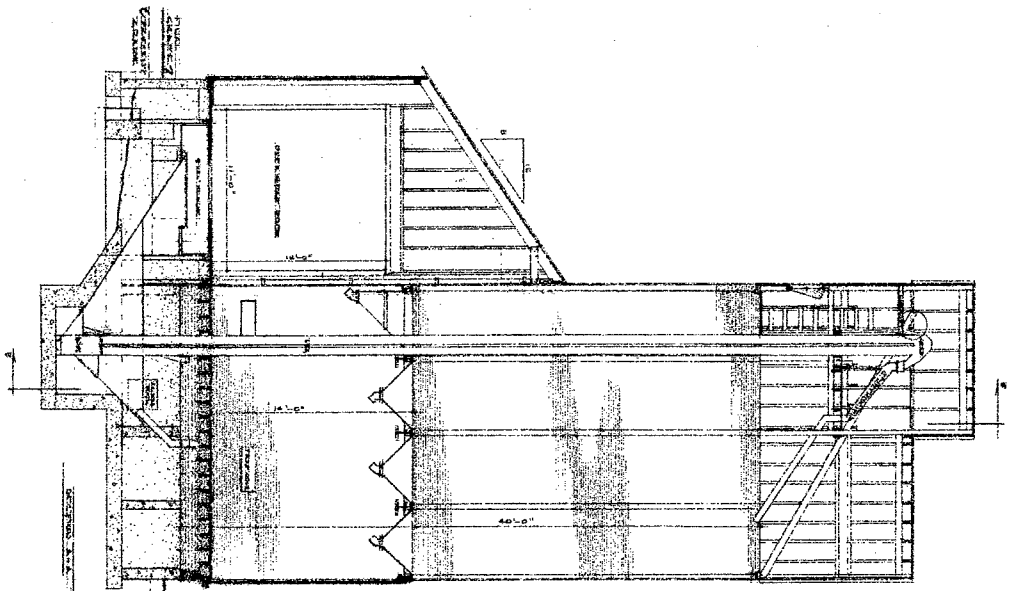


SECTIONAL DRAWING

ARCHITECTURAL ENGINEERING  
 UNIVERSITY OF CALIFORNIA  
 ARCHITECTURAL ENGINEERING DEPARTMENT  
 BERKELEY, CALIFORNIA  
 PROJECT: [illegible]  
 DATE: [illegible]

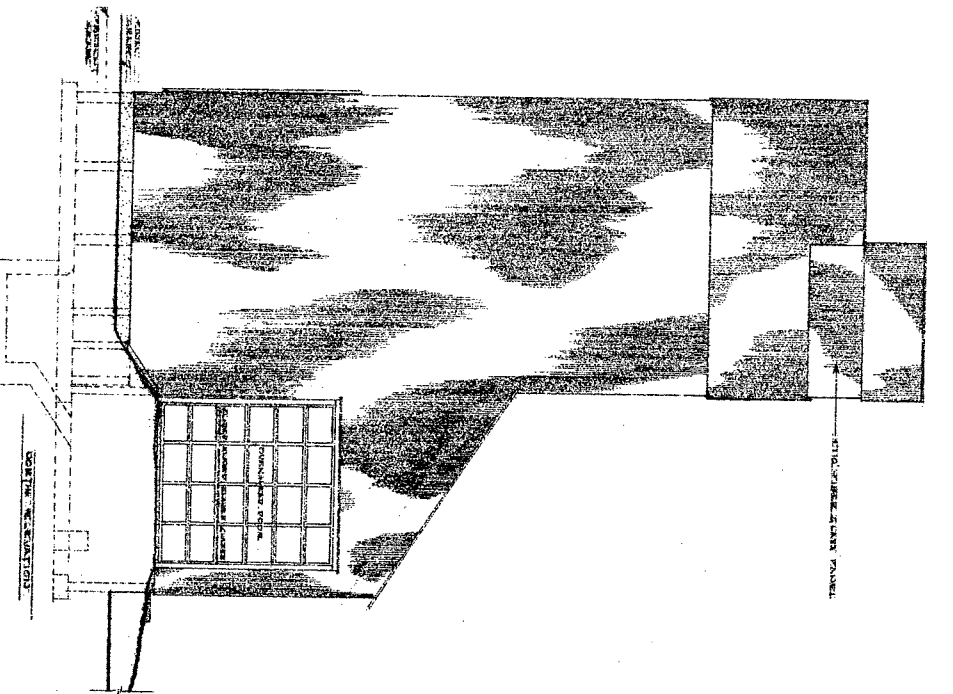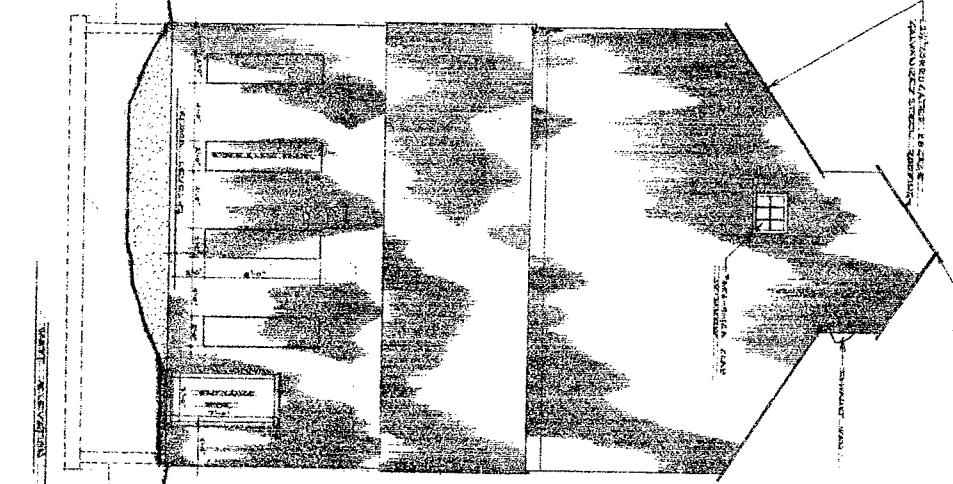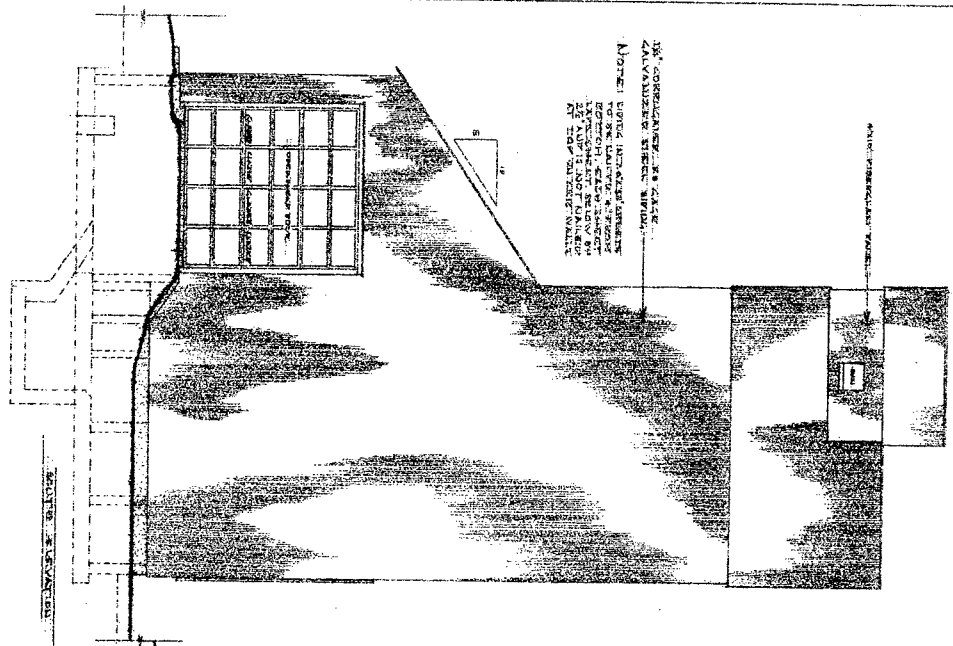





ELEVATIONS

NORTH CAROLINA STATE DEPARTMENT OF AGRICULTURE, 1800 S. W. CORCORAN ST., RALEIGH, N. C.  
 ARCHITECTURAL DEPARTMENT  
 DRAWING NO. 1800 S. W. CORCORAN ST., RALEIGH, N. C.  
 SCALE: 1/4\"/>

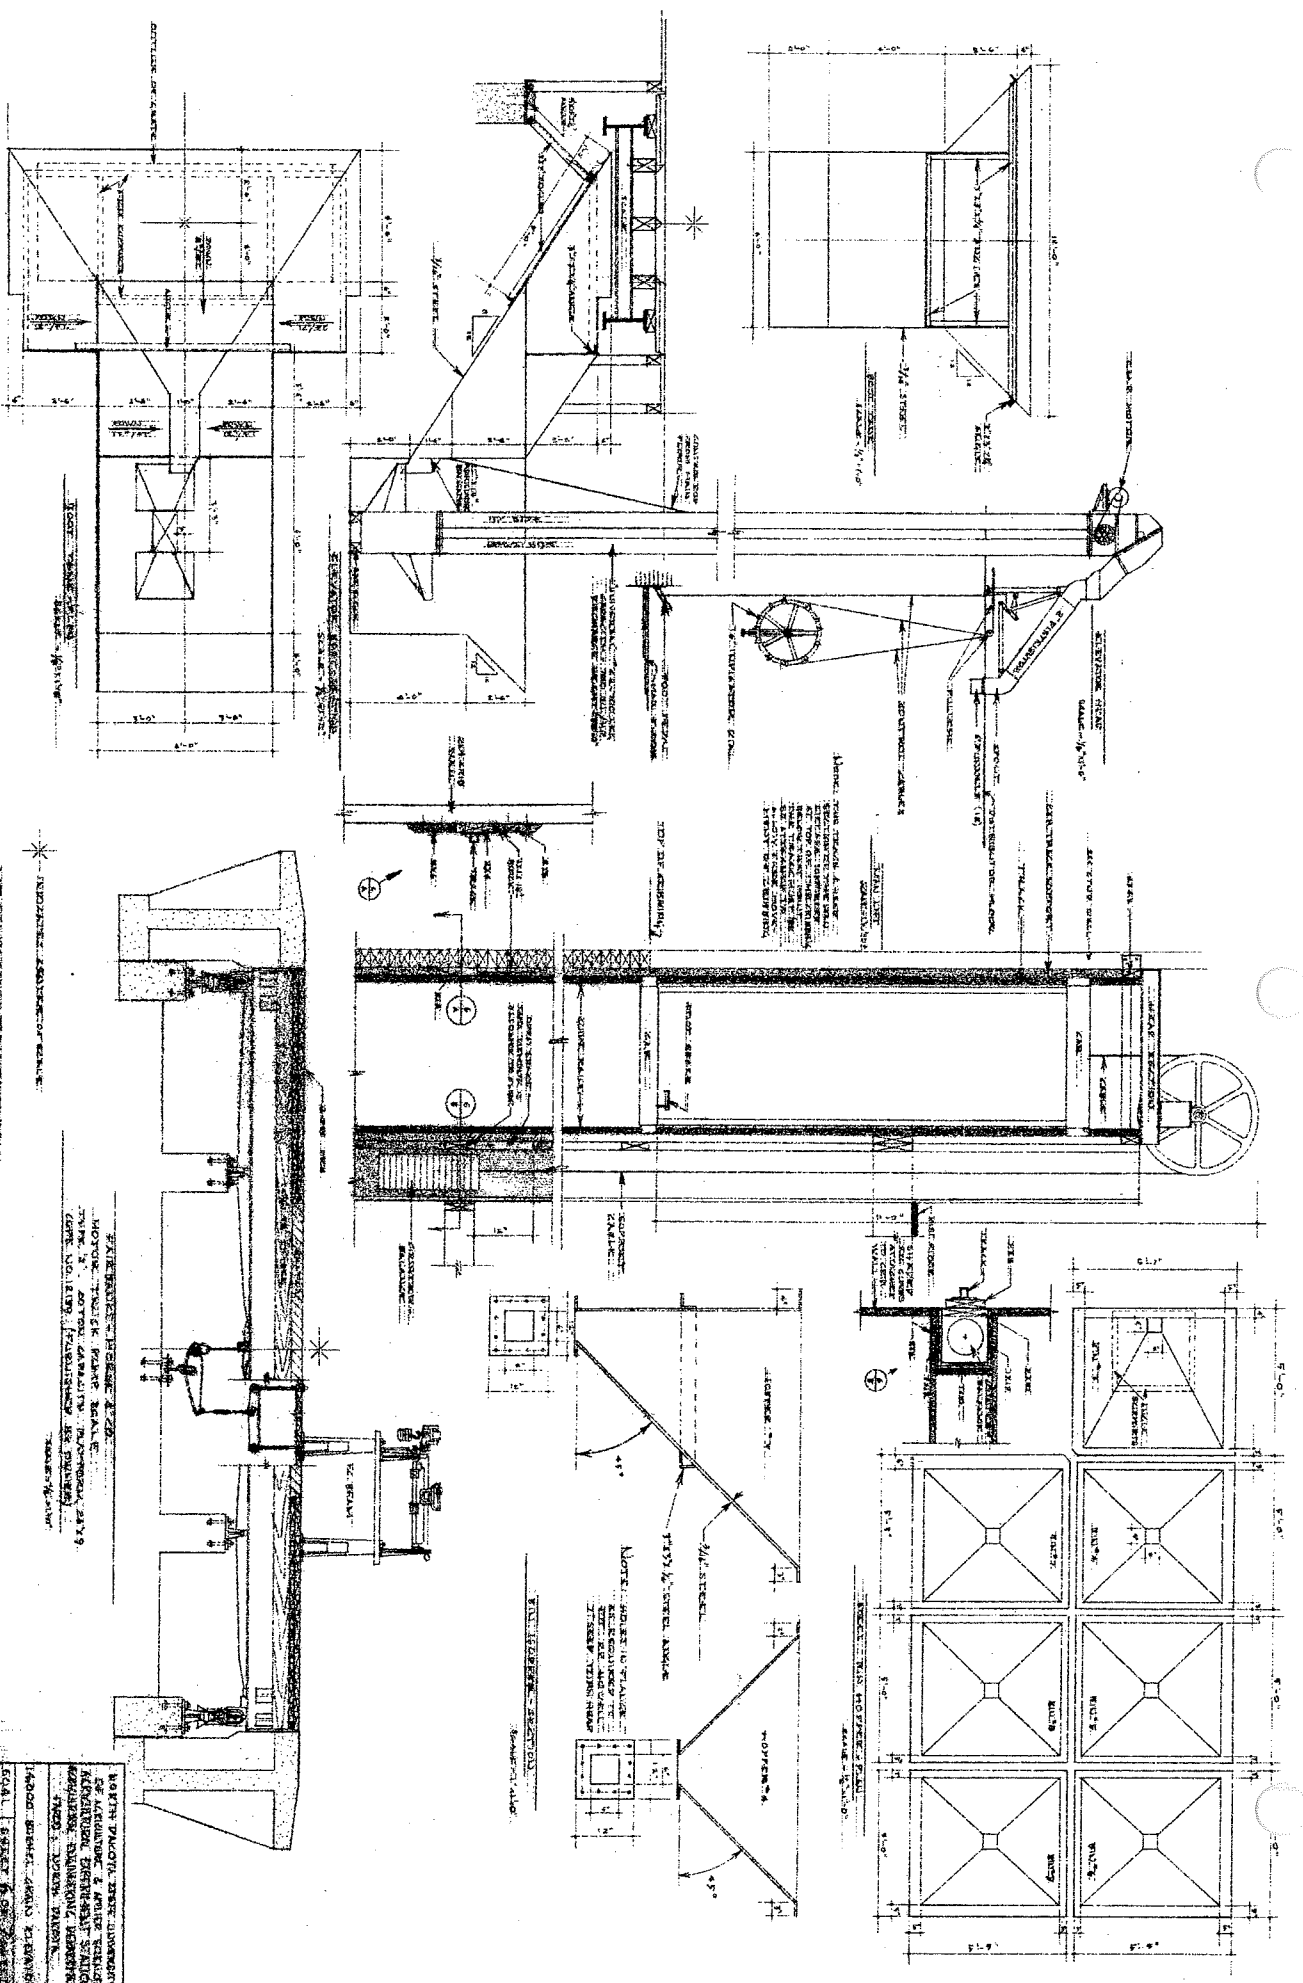


BOILING PLANT, 100HP BOILER ROOM  
 ARCHITECTURAL & MECHANICAL  
 DRAWINGS FOR THE BOILING PLANT  
 AND BOILER ROOM. DRAWN BY  
 J. H. B.

100HP BOILER ROOM

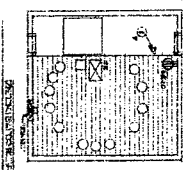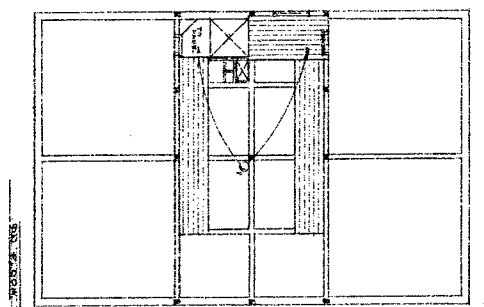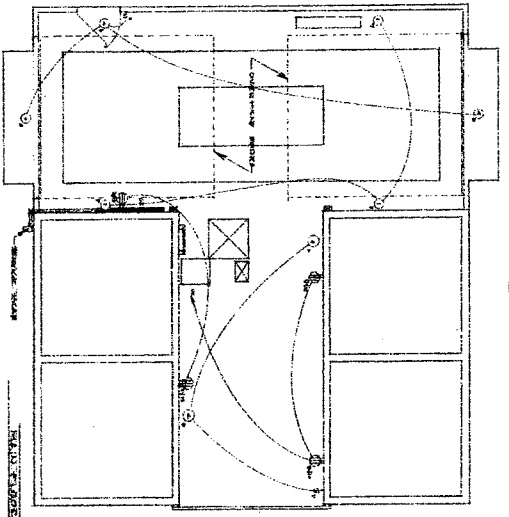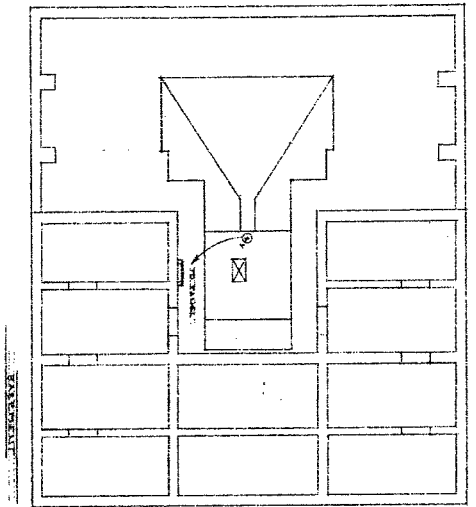

- TABLE 1-1  
LIGHTING
- 1 LIGHTING OUTLETS
  - 2 LIGHTING OUTLETS
  - 3 LIGHTING OUTLETS
  - 4 LIGHTING OUTLETS
  - 5 LIGHTING OUTLETS
  - 6 SPANNEZ CIRCUIT
  - 788 ELEVATOR LEAD PINS
  - 740 POWER OUTLETS
  - 1412 POWER OUTLETS

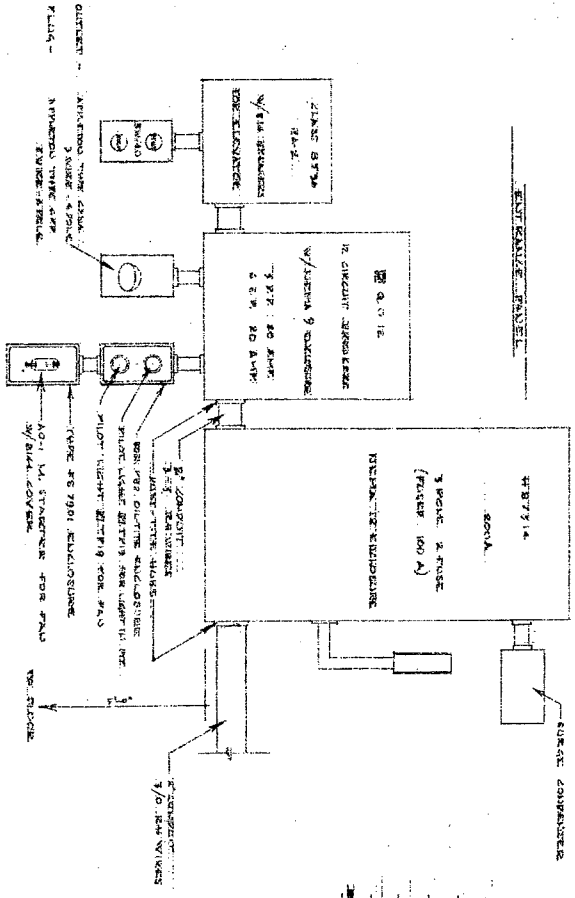

NO.	DESCRIPTION	UNIT
0	STANDARD PANEL 4/24	1
0	PARTICULAR LIGHTING	
0	STANDARD SECTION	
0	PARTICULAR SINGLE-POLE SWITCH	
0	PARTICULAR POWER OUTLET 1/4-0	
0	STANDARD PANEL	

INVESTIGATION REPORT

STATE UNIVERSITY OF NEW YORK  
 COLLEGE OF ENGINEERING AND APPLIED SCIENCE  
 SUTHERLAND AVENUE  
 SUTHERLAND AVENUE  
 SUTHERLAND AVENUE